DEPARTMENT OF VETERANS AFFAIRS MEDICAL CENTER 4801 E. LINWOOD BOULEVARD KANSAS CITY, MISSOURI 64128

Project #589-CA3-472 CONSTRUCT OEF/OIF AND SPECIALTY CARE ADDITION Kansas City VA Medical Center


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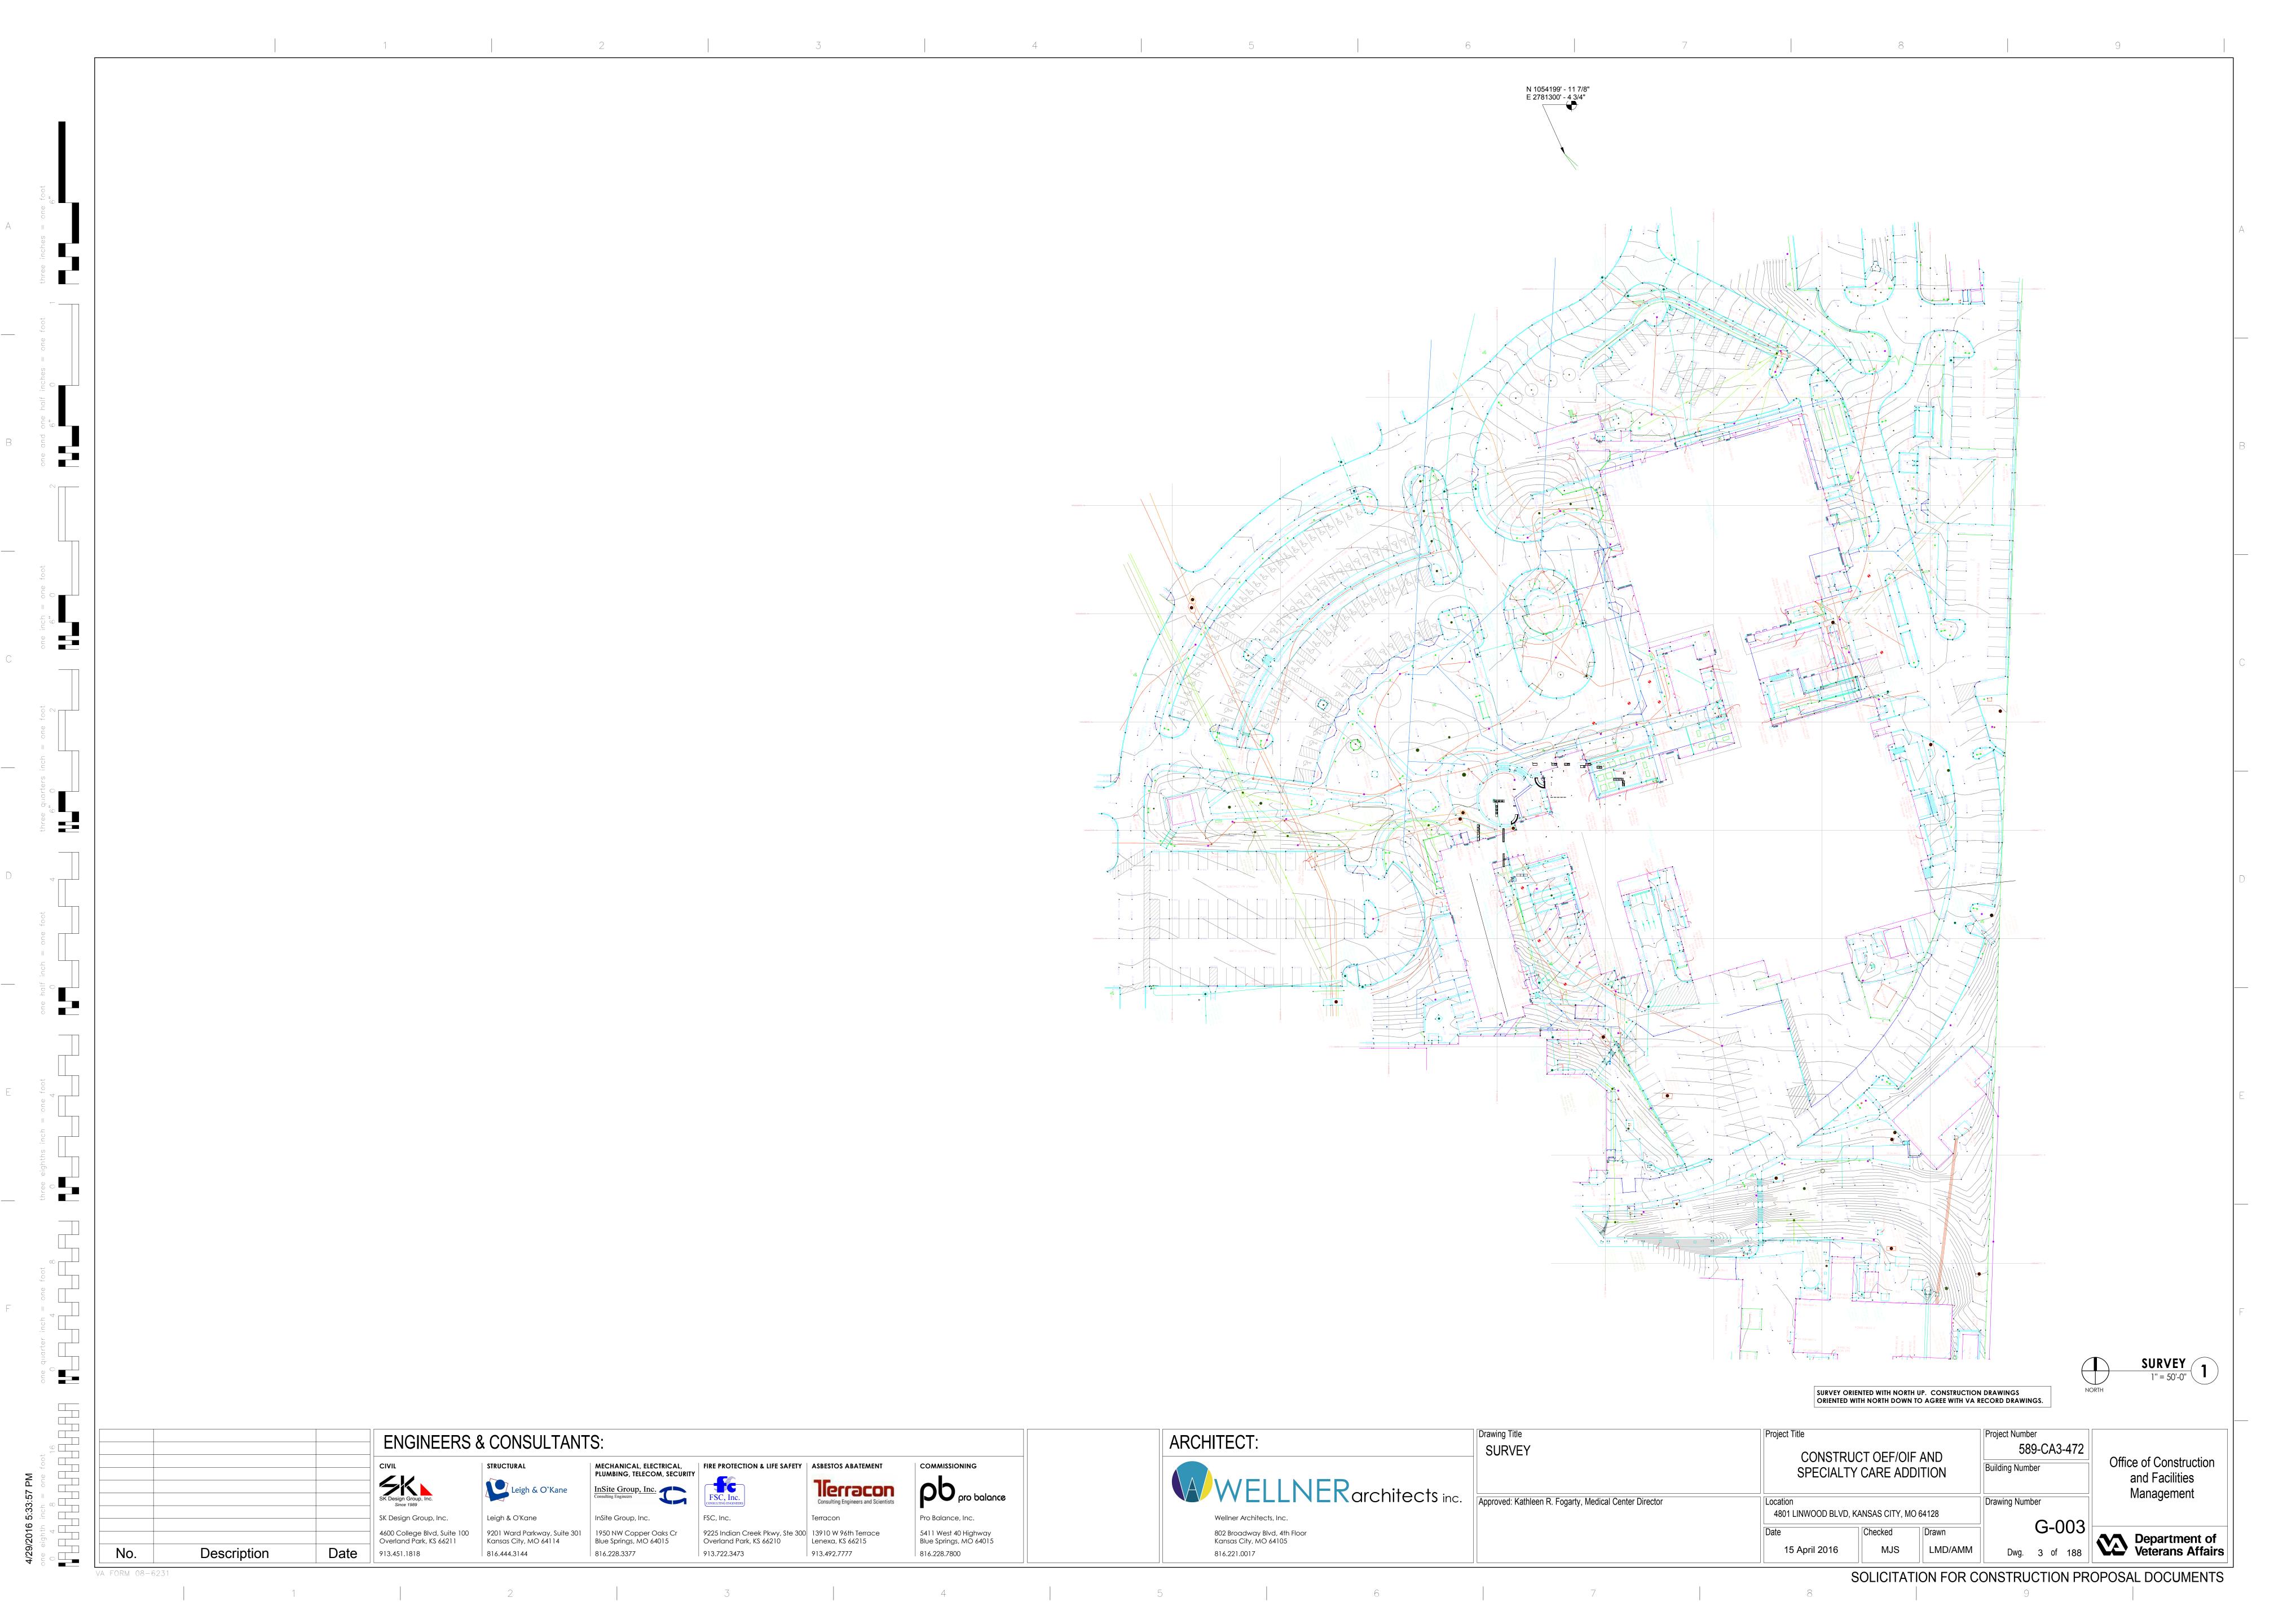
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32	S-111	FOUNDATION PLAN, BLDG 1, BASE BID AND DEDUCT 2	97	A-323	WALL SECTIONS	160	MP102	BASEMENT MECHANICAL PIPING PLAN, BLDG 1
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58	A-002	PARTITION TYPES	123	FA001	FIRE ALARM GENERAL NOTES	180	E-601	ELECTRICAL LIGHTING FIXTURE SCHEDULE
59	A-003	ABBREVIATIONS, SYMBOLS AND VA FACILITY SITE PLAN	124	FA102	FIRE ALARM BASEMENT AND SUB-BASEMENT PLANS BLDG 1	181	E-602	ELECTRICAL PANEL SCHEDULES
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61	A-005	FIRE RATED ASSEMBLIES	126	FA104	FIRE ALARM 2ND AND 3RD FLOOR PLANS	100	TN 11 00	VA TELECOMMANIANIC ATIONIC COFCIFICATIONIC
62	A-006	FIRE RATED ASSEMBLIES	127	FX001	FIRE SUPPRESSION GENERAL NOTES	183 184	TN100 TN103	VA TELECOMMUNICATIONS SPECIFICATIONS TELECOM DATA NETWORKS 1ST FLOOR PLAN, BLDG 1
			128	FX102	FIRE SUPPRESSION GENERAL NOTES FIRE SUPPRESSION BASEMENT AND SUB-BASEMENT FLOOR PLANS BLDG 1	185	TN103.A	TELECOM DATA NETWORKS 1ST FLOOR PLAN, BLDG 1. TELECOM DATA NETWORKS 1ST FLOOR PLAN, BLDG 1, DEDUCTS 7 AND 8
			129	FX103	FIRE SUPPRESSION 1ST FLOOR PLAN BLDG 1	186		TELECOM DATA NETWORKS 2ND AND 3RD FLOOR PLANS, BLDG 1
			130	FX104	FIRE SUPPRESSION 2ND AND 3RD FLOOR PLANS			
						187	TY103	SECURITY 1ST FLOOR PLAN, BLDG 1
						188	TY104	SECURITY 2ND AND 3RD FLOOR PLANS BLDG 1

SIGNATURE B	LOCK	
Harold R. Martin, Project Manager	Date	
Greg Massey, Chief of Projects	Date	
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George H. Hazel, Chief Facilities Management	Date	
Donald Barnett, Deputy Chief of Staff	Date	
	3	
Kovin Inklay Associate Director	Data	
Kevin Inkley, Associate Director	Date	

Project Title **Project Number ENGINEERS & CONSULTANTS: COVER AND INDEX OF DRAWINGS** CONSTRUCT OFF/OIF AND Office of Construction MECHANICAL, ELECTRICAL, | FIRE PROTECTION & LIFE SAFETY | ASBESTOS ABATEMENT SPECIALTY CARE ADDITION PLUMBING, TELECOM, SECURITY and Facilities LNERarchitects inc. Approved: Kathleen R. Fogarty, Medical Center Director Management **Drawing Number** Consulting Engineers and Scientists Since 1989 4801 LINWOOD BLVD, KANSAS CITY, MO 64128 SK Design Group, Inc InSite Group, Inc. Pro Balance, Inc. Wellner Architects, Inc. Checked 9225 Indian Creek Pkwy, Ste 300 | 13910 W 96th Terrace 5411 West 40 Highway 4600 College Blvd, Suite 100 1950 NW Copper Oaks Cr 802 Broadway Blvd, 4th Floor Department of Kansas City, MO 64105 Overland Park, KS 66211 Kansas City, MO 64114 Blue Springs, MO 64015 Overland Park, KS 66210 Lenexa, KS 66215 Blue Springs, MO 64015 Description 816.228.7800 816.444.3144 816.228.3377 913.722.3473 913.492.7777 816.221.0017

VA FORM 08-623



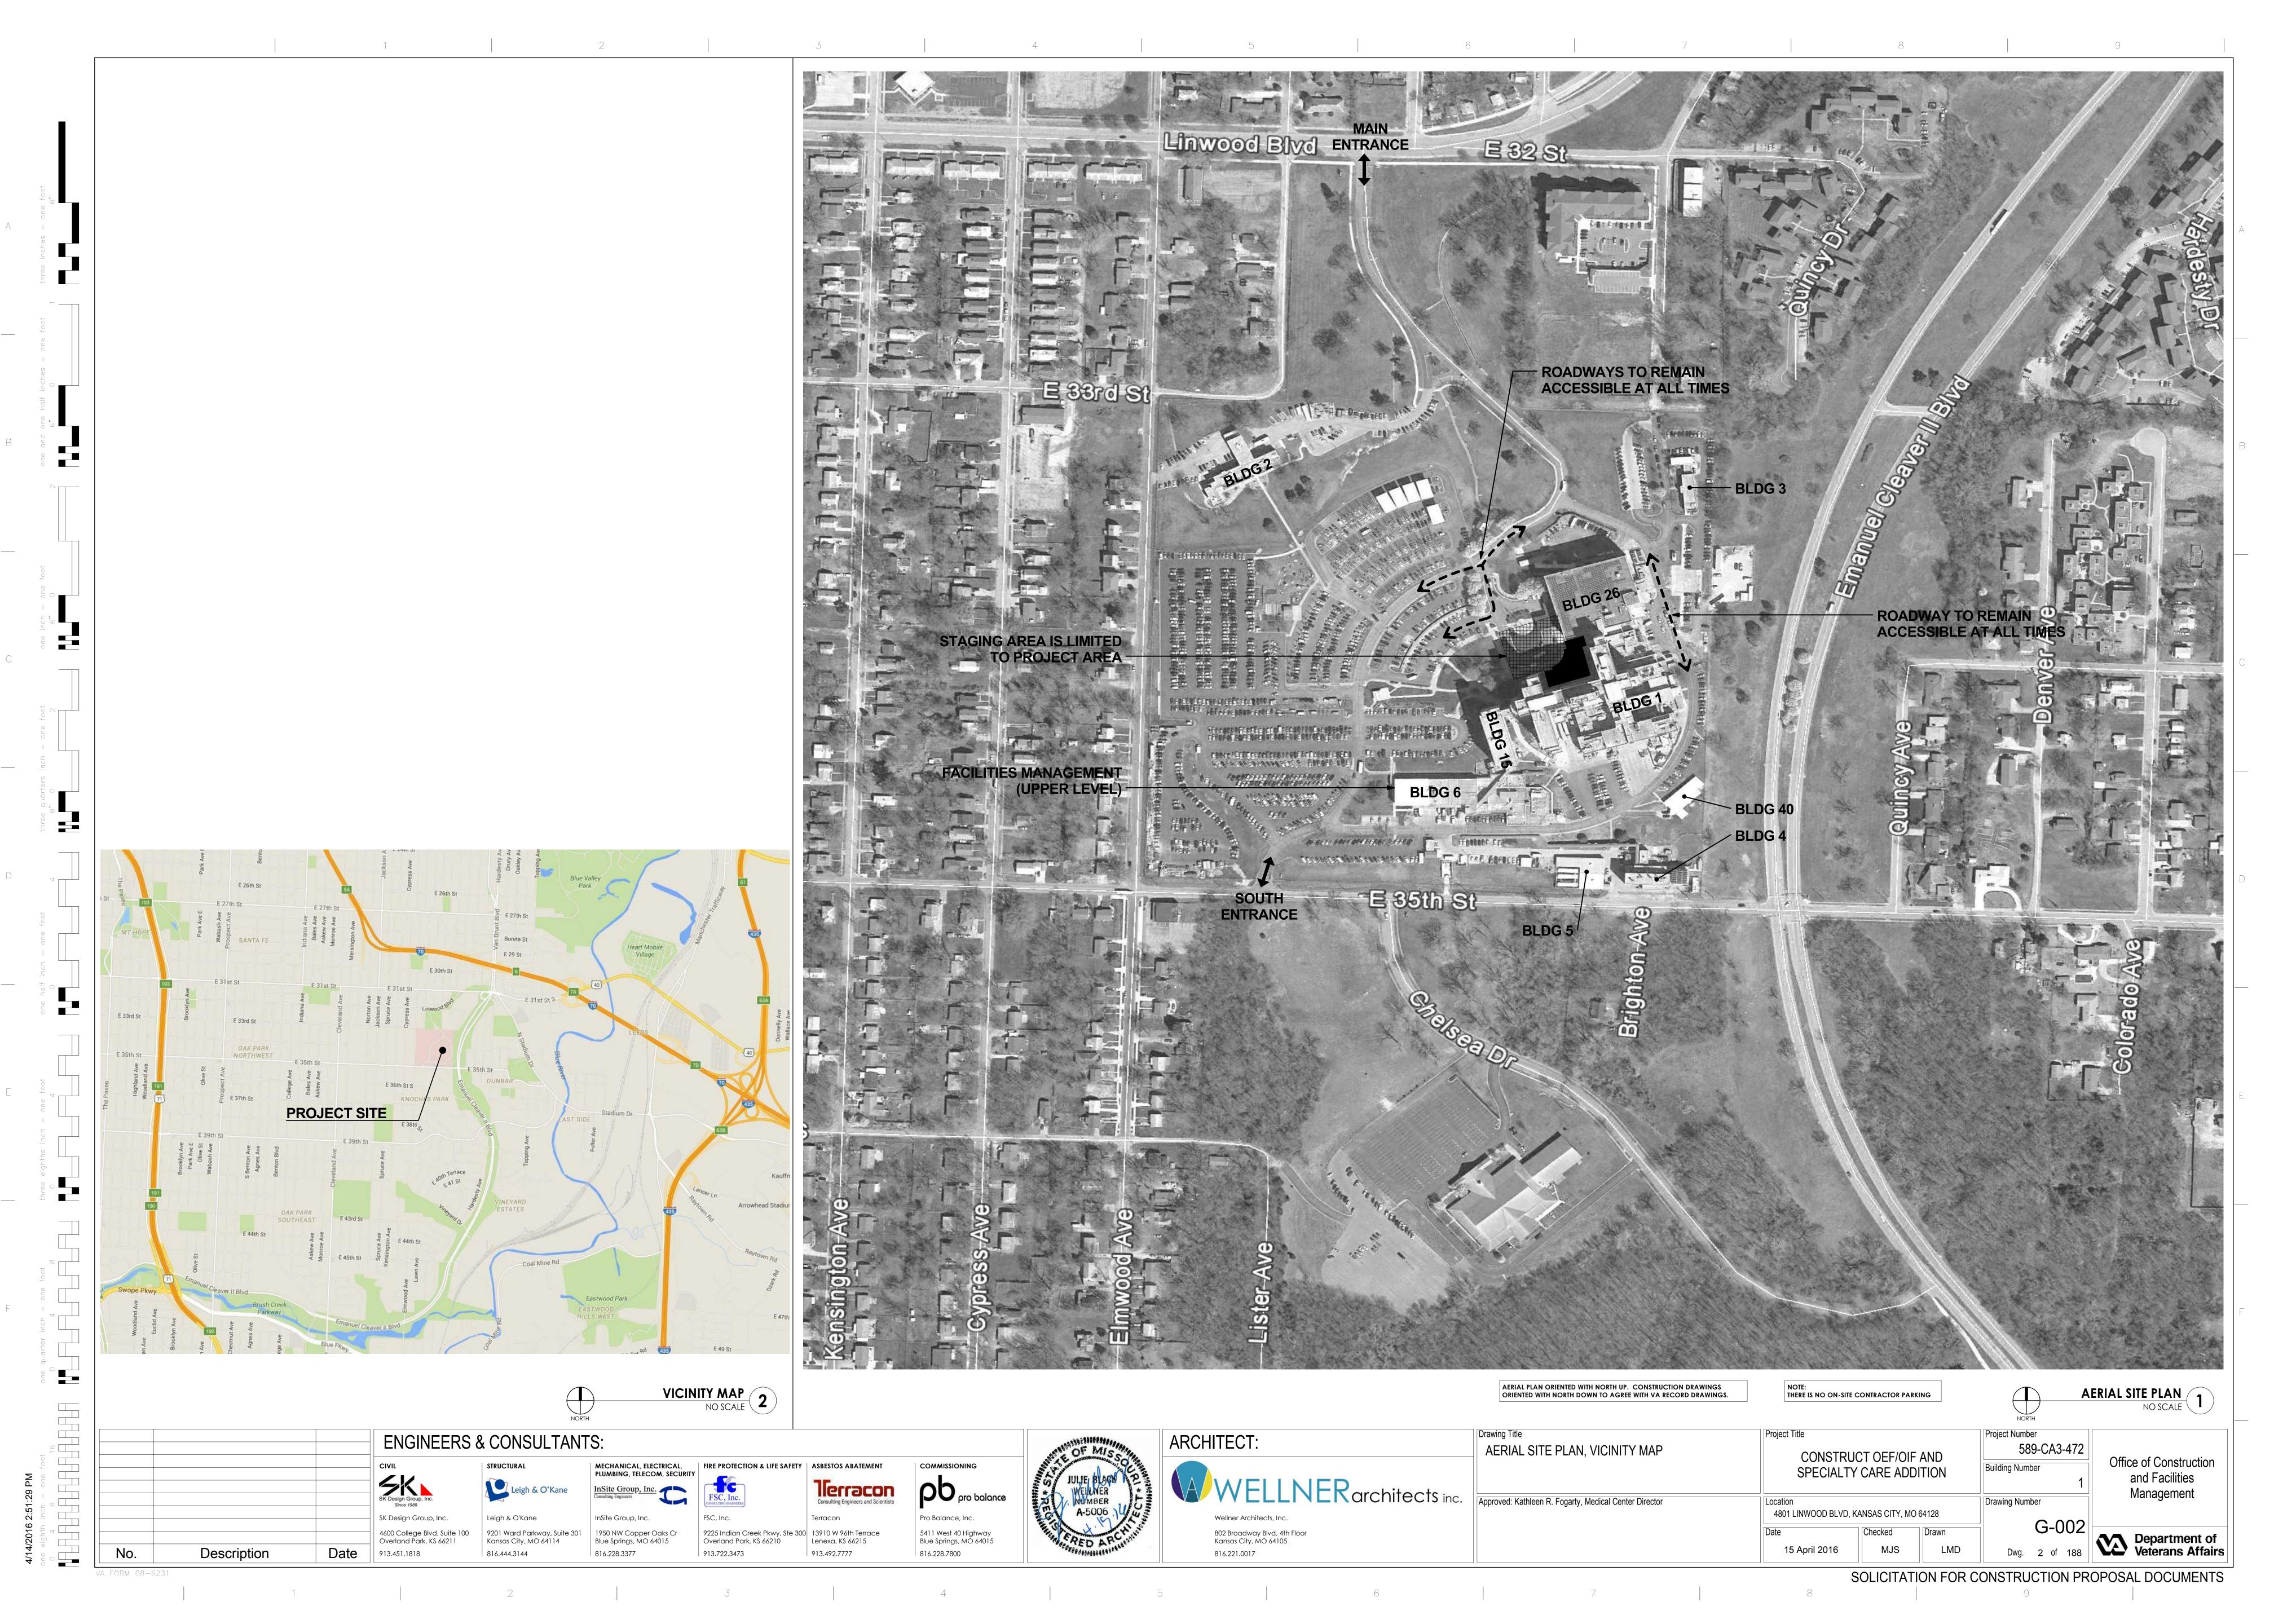

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1	1A	OMIT INSTALLATION OF LOBBY SCULPTURE. (SCULPTURE PROVIDED BY OWNER) OMIT PLYWOOD BACKING FOR SUPPORT. OMIT (3) "J" TYPE LIGHT FIXTURES ON LOBBY WALL. CHANGE (3) "B6" TYPE LIGHT FIXTURES IN LOBBY CEILING TO "B3" TYPE FIXTURES AND MOVE TO CIRCUIT 5 ON PANEL "L-1". RE: 1 EL113, 1EL114.	4		OMIT ELEVATOR CORE, & DELETE 2ND & 3RD FLOORS: OMIT ASBESTOS ABATEMENT AT 2ND & 3RD FLOORS. DELETE PIT, LADDERS, SUMP & GRATE. OMIT SUMP PUMP AND ASSOCIATED DRAIN AND VENT PIPING. OMIT 6" PIPE SERVING ELEVATOR PIT FOUNDATION DRAINAGE. OMIT CMU SHAFT WALL ON THREE SIDES & MTL STUD SHAFT WALL ON ONE ON 3 LEVELS.	6		DO NOT RELOCATE POLICE FROM V1-673. OMIT MASONRY WALLS AROUND COMMAND/ID & HOLD ROOM. MAINTAIN THICKENED SLAB FOR FUTURE WALLS. OMIT BALISTIC-REISTANT TRANSACTION WINDOWS & COUNTERS. OMIT BALISTIC-RESISTANT DOORS & FRAMES W/ ACCESS CONTROL HARDWARE. OMIT IMPACT RESISTANT DOOR & FRAME & IMPACT-																							
	1B	OMIT INTERIOR SIGNAGE & WAYFINDING KIOSK. PROVIDE ONLY GROUND-MOUNTED BUILDING SIGN, EXTERIOR DIRECTIONAL SIGNAGE, & INTERNALLY ILLUMINATED CABINET SIGN MOUNTED TO DROP-OFF CANOPY.							& 3RD FLOORS INCLUDING EXTERIOR STUD WALLS, EIFS SIDING, 4 ALUMINUM STOREFRONT TYPE B WINDOWS, AND TWO EXTERIOR DOORS, FRAMES & HARDWARE. ELIMINATE SFRM OMIT RELOCATING REMOTE FIRE ALARM PANEL & REMOTE ANNI INCIATOR PAN			SYSTEM. IN LIEU OF ID/COMMAND, EXTEND WAITING AREA FINISHES INTO AREA. OMIT RELOCATING REMOTE FIRE ALARM PANEL & REMOTE ANNUNCIATOR PANEL. OMIT 4																			
	1C	INSTALL RESLIENT SHEET FLOORING IN LIEU OF LUXURY VINYL TILE			FROM 2ND & 3RD FLOORS & REDUCE SFRM ON COLUMNS FORMERLY SUPPORTING FLOORS FROM 3-HOUR TO 2-HOUR. PROVIDE 1-HOUR SFRM ON 1ST FLOOR ROOF AREA FORMERLY			SMOKE DETECTORS FOR COUNTER SHUTTRS. PROVIDE SPRINKLERS & SMOKE DETECTION FOR NEW SEATING AREA.																							
	1D	PAINT GYP BOARD IN LIEU OF WOOD WALLCOVRING ON EAST LOBBY WALL AND AT PACT RECEPTION. REVEAL PATTERN TO REMAIN.			2ND FLOOR BRIDGE TO BLDG 1. OMIT EXPANSION JOINTS SHOWN ON A-126 & A-324. OMIT GUTTERS, DOWNSPOUTS & SPLASH PANS FROM 3RD & 2ND FLOOR ROOFS TO LOWER ROOFS. REDUCE LF OF COPING. OMIT INTERIOR FLOOR, WALL, & CEILING FINISHES & WALL			OMIT RELOCATING REMOTE GENERATOR ANNUNCIATOR PANELS, NURSE CALL REMOTE ANNUNCIATOR, & SECURITY SERVER RACK. OMIT 1 VAV BOX, HEATING HOT WATER PIPING																							
	1E	OMIT PASS-THRU WALL CABINETS IN ROOMS PACT ROOM M1-311, M1-313, M1-317, M1-319. PROVIDE COMPLETE WALL & BACKS ON WALL CABINETS.				PROTECTION SYSTEMS AT 2ND & 3RD FLOORS. REFER TO 2/A-103.A FOR DEDUCT 4 1ST FLOOR PLAN. PROVIDE EMS ROOM IN LIEU OF	7		DUCTWORK & CONTROLS. REDUCE AREA & VOLUME OF LORBY RE: 1/A-103 B. REDUCE LORBY AREA & HEIGHT TO																						
	1F	OMIT SECURITY CAMERA SYSTEM: PROVIDE RACEWAYS, JUNCTION BOXES, CONDUITS AND PULL STRINGS TO EQUIPMENT LOCATIONS SHOWN FOR INSTALLATION. EQUIPMENT AND WIRING PROVIDED BY OTHERS. RE: TY SHEETS.														ELEVATOR MACHINE ROOM (WALL TYPE 16A, DOOR TYPE 1, 3'-6" X 7'-0", FRAME TYPE A, HARDWARE SET 5D). REVISE CEILING FINISH, RE: 2/A-113. PROVIDE SERVICE SINK (PLUMBING FIXTURE TYPE P-502) IN EMS ROOM AND PROVIDE ASSOCIATED DOMESTIC COLD WATER, DOMESTIC HOT WATER, DOMESTIC HOT WATER CIRCULATION, WASTE, AND VENT PIPING TO ADEQUATELY SERVE THE SERVICE SINK. PROVIDE 1/2" CHECK VALVE, 1/2" BALANCING VALVE, 1/2" FULL PORT BALL VALVE, AND 1" FULL PORT BALL VALVE FOR	/		REDUCE AREA & VOLUME OF LOBBY, RE: 1/A-103.B. REDUCE LOBBY AREA & HEIGHT TO SINGLE STORY WITH PARAPET HEIGHT TO MATCH HEIGHT SHOWN ON 1/A-325. METAL STUE WALLS W/ DECORATIVE CMU VENEER TO REMAIN AT EACH END OF ADDITION. REPLACE CURTAINWALL ALONG NORTH & WEST WALLS WITH 6" STOREFRONT. PROVIDE VESTIBULE 6" STOREFRONT FRAMING W/ REVOLVING DOOR SAME AS M1-300.1. PROVIDE TWO 4' X 7' WIDE-STILE ALUMINUM SWINGING DOORS W/ 9/16" LAMINATED GLASS & WITH DOOR BELLS,												
	1G	OMIT INTERACTIVE WHITEBOARD IN MED APPT M1-322. PROVIDE POWER, DATA & BRACING IN WALL.															DOMESTIC HOT WATER CIRCULATION PIPING. PROVIDE ROOF ACCESS ROOM M1-372 (WALL TYPE 16A, DOOR TYPE 1, 3'-0" X 7'-0", FRAME TYPE A, & HARDWARE SET 20) OPPOSITE EMS M1-371. PROVIDE 30" X 36" INSULATED ROOF SCUTTLE & ALUMINUM ACCESS LADDER TO 1ST			CARD READERS &THE FOLLOWING HARDWARE PER DOOR: CONTINUOUS HINGE, EXIT D WITH ELECTRIC LATCH RETRACT, CYLINDER AS APPROPRIATE, DOOR OPERATOR, GASKETING, ELECTROLYNX HARNESS, TWO PUSH BOTTONS (MOUNT ON INTERIOR &											
	1H	REPLACE DEMOUNTABLE PARTITIONS WITH CONVENTIONAL CONSTRUCTION: REVISE SOUTH, EAST & WEST WALL OF REGISTRATION TERMINAL M1-351 THRU M1-355& EAST & WEST WALL OF M1-356 TO METAL STUD & GYP BD WALL TYPE 16. DOORS ARE TO BE TYPE 3 IN TYPE C FRAMES WITH HARDWARE SET 19. OMIT GLASS PANELS ON WEST WALL. OMIT MAGNETIC GLASS PANEL INSIDE REGISTRATION TERMINALS.																											FLOOR LOW ROOF. EXTEND LOBBY FINISHES INTO REMAINING AREA. ON ROOF, PROVIDE ALUMINUM LADDER FROM LOW ROOF TO HIGH ROOF. CONTINUE GUTTERS TO SOUTHEAST CORNER & PROVIDE 2 ADDITIONAL DOWNSPOUTS. ADD ROOF DRAIN & OVERFLOW BTWN GRID LINES WEST OF G. EQUALLY SPACE ROOF DRAINS EAST TO WEST ALONG SOUTH SIDE OF BLDG 1. ROUTE AS SHOWN ON P-106.A.	EXTERIOR COLUMN COVERS), THRESHOLD, KEY SWITCH, POWER SUPPLY, & REMOTE RELEASE LOCATED AT INFORMATION BOOTH. MOVE DOOR M1-300.4 TO WEST WALL OF VESTIBULE. PROVIDE CARD READER & HARDWARE PER BASE BID, WITH REMOTE RELEASE INFORMATION BOOTH. PROIVDE 2-HR SFRM AT COLUMNS & BEAMS, & 1-HOUR SFRM AT ROOF. PROVIDE COLUMN COVERS.	
2	2A	PAINT WALLS. INSTALL RB POWER & DATA ARE TO BE PROVIDED PER BASE BID. OMIT DROP-OFF & WALKWAY CANOPIES. WALKS TO REMAIN AS SHOWN. OMIT INTERNALLY ILLUMINATED CABINET SIGN. REFER TO C-601 FOR BOLLARD LOCATIONS. REFER TO 4/C-			FRAME LOW ROOF AS SHOWN ON S-121.A . DROP ROOF DECK TO ELIMINATE OFFSET IN AREA OF NEW DECK BOUNDED BY 1-1.11 TO 4-1.11 & G1 TO G4. REVISE SOUTHEAST			REVISE GRADING AS SHOWN ON C-601. EXTEND STORM LINES FROM TWO VESTIBULE ROC DRAINS TO 10" STORM LINES AS SHOWN ON C-601.																							
		503 FOR BOLLARD FOUNDATIONS. OMIT TYPE "O" FIXTURES SHOWN UNDER DROP-OFF AND WALKWAY CANOPIES. RE: 1EL113.			CORNER OF HIGH LOBBY ROOF FRAMING AS SHOWN ON S-122.A . ELIMINATE 3RD FLOOR FRAMING SHOWN ON 1/S-122 AND ROOF FRAMING SHOWN ON 2/S-122.			REDUCE AREA OF SOG. REDUCE COLUMN HEIGHTS. REFRAME ALL ROOF AREAS NORTH C GRID LINE 6 & WEST OF GRID LINE D FOR SAME ROOF HEIGHT AS ROOF SOUTH OF GRID LI 6 & EAST OF GRID LINE D. REFER TO S-101.B FOR REVISED CAISSON LOCATIONS. REFER																							
	2В	OMIT MODIFICATIONS TO BUILDING 26 CANOPY: REVISE DRIVE TO ALLOW FOR CANOPY FRAMING TO REMAIN IN PLACE AS SHOWN ON C-601. EXTEND SIDEWALK ALONG DRIVE TO BLDG 26 WITH BOLLARDS SPACED AS SHOWN ON BID DOCUMENTS. OMIT ALL ELECTRICAL			OMIT FIRE ALARM ITEMS ASSOCIATED W/ ELEVATOR. DELETE FIRE ALARM SYSTEM ON 2ND & 3RD FLOORS. DELETE SPRINKLERS ON 2ND & 3RD FLOORS. RESPACE SPRINKLERS TO COVER ADDED 1ST FLOOR AREA.			S-11.B FOR REVISED FOUNDATION PLAN. REFER TO S-121.B FOR REVISED ROOF FRAMING REDUCE AREA OF FIRE SPRINKLERS & SMOKE DETECTORS.																							
3		DEMOLITION WORK AND INSTALLATION OF NEW LIGHT FIXTURES. RE: 2EL113 OMIT ELEVATORS E-23 & E-24 (CARS, CABS, CONTROLLER, CONTROLS, PUMP UNIT ASSEMBLY, HYDRAULIC ASSEMBLY, GUIDE & RAILS). PROVIDE INFRASTRUCTURE FOR FUTURE ELEVATOR INCLUDING CMU WALL, SHAFT WALL, SUMP & GRATE, & POWER. PROVIDE LIFT BEAM & ELEVATOR RAILS. PROVIDE TWO 4" CONDUIT ABOVE CEILING OF MEN M1-370 FROM ELEVATOR MACHINE ROOM M1-371 TO SOUTH WALL OF ELEVATOR CORE FOR FUTURE HYDRAULIC LINES & TWO 2-1/2" X 4" WIRE DUCT FOR FUTURE WIRING. PROVIDE FIRESTOPPING AT CONDUIT PENETRATION TO MAINTAIN 2-HOUR RATING. EXTEND SHAFT	5	5	5	5	5								5	5												OMIT MEP WORK ASSOCIATED WITH ELEVATOR AND 2ND & 3RD FLOORS INCLUDING VAV BOXES VAV-25 AND VAV-26 ANDINCLUDING ALL ASSOCIATED DUCTWORK, AIR DEVICES, HEATING HOT WATER PIPING, LIGHTING, CONDUIT & WIRING. OMIT LIGHTING, POWER, DATA, AND ROUGH-IN FOR SECURITY DEVICES IN 2ND AND 3RD FLOOR BRIDGE. DELETE CONDUIT & WIRING TO ELEVATORS. OMIT SUMP PUMP SP-1 AND ASSOCIATED WASTE PIPING, VENT PIPING, ELECTRICAL POWER, AND FLOAT ALARM PANEL. OMIT BREAKERS AND CIRCUITS SERVING ELEVATORS AND SUMP PUMP. OMIT ELEVATOR PIT LIGHTING AND SERVICE RECEPTACLES. OMIT DX COOLING SPLIT SYSTEM (INDOOR AND OUTDOOR UNITS) FROM ELEVATOR EQUIPMENT ROOM & ROOF.			REDUCE AIR HANDLING EQUIPMENT CAPACITY BY 10% (1,000 CFM REDUCTION TO 9,000 CF DOWNSIZE VAV BOX TERMINAL UNITS VAV-12. VAV-16, VAV-22, & VAV-24. RECONFIGURE DUCTWORK AND AIR DEVICES, LOCATE DIFFUSERS AND RETURNS IN LAY-IN CEILING. RELOCATE ALL HOT WATER RADIATORS AND ADD TWO RADIATORS, MOVE AC-1 AIR CURTAINS TO BE ABOVE NEW SLIDING DOOR LOCATIONS, REROUTE HYDRONIC PIPING AS REQUIRED TO SERVE NEW RADIATOR AND AIR CURTAIN LOCATIONS. REDUCE AREA OF INTERIOR LIGHTING. INCREASE SIZE OF STORM AND OVERFLOW DRAIN SERVING ROOF DRAIN AREA #3 TO 8" TO ACCOMODATE REVISED ROOF LAYOUT.
		WALL & LOBBY WALL BTWN NORTH & SOUTH MASONRY HOISTWAY WALLS ON 1ST, 2ND, & 3RD FLOORS. INSTALL SCHEDULED WALL TILE. PROVIDE CONDUIT & BACKBOXES FOR ROUGH-IN OF FUTURE ELEVATOR FIRE DETECTION DEVICES. OMIT ACTUAL DETECTION DEVICES & WIRING. PROVIDE PIPE & CAP FOR FUTURE ELEVATOR SPRINKLER ROUGH-IN. PROVIDE DX COOLING SPLIT SYSTEM (INDOOR AND OUTDOOR UNITS) FOR ELEVATOR EQUIPMENT ROOM. PROVIDE SPACES IN ELECTRICAL PANELS AND CONDUITS WITH PULL STRING FOR FUTURE ELEVATOR CIRCUITS. PROVIDE SUMP PUMP AND ASSOCIATED DRAIN AND VENT PIPING AS SHOWN IN BASE BID.						5	5	5	5	5	5	5			OMIT VESTIBULE RE: 1/A-103.A: OMIT 2 EXTERIOR COLUMN COVERS, DELETE TPO ROOFING & INSULATION. OMIT SHEET METAL FLASHING & FASCIAS. OMIT VESTIBULE SFRM. CENTER REVOLVING DOOR M1-300.1 IN LINE WITH MAIN BUILDING WALL ALONG GRIDLINE R2. MOVE TWO AUTOMATIC SINGLE SLIDING DOORS WITH SIDELIGHTS (M1-300.2 & M1-300.3) IN LINE WITH MAIN BUILDING WALL. OMIT CURTAINWALL FRAMING FOR TWO-STORY INTERIOR VESTIBULE. OMIT ONE 14' OVERALL DBL AUTOMATIC SLIDING DOOR (M1-300.4). REDUCE AMOUNT OF WALK-OFF MAT TO WITHIN THE REVOLVING DOOR & 6' IN FRONT OF SLIDING DOORS. OMIT 2 WHEELCHAIR STORAGE AREAS.	8		LEAVE EXISTING RESTROOMS & 2 OFFICES IN PLACE, RE: 1/A-103.C. OMIT ALL INTERIOR DEMOLITION & FINISH WORK REQUIRED TO PROVIDE 6 NEW OFFICES IN FORMER PUBLIC RESTROOM AREA, & TO PROVIDE NEW PUBLIC RESTROOMS IN ADDITION. LOCATE SUITE COFFICES, ELECTRICAL ROOM, & ROOF ACCESS & ELECTRICAL ROOM IN AREA WHERE NEW RESTROOMS WERE TO BE. WALL TYPES ARE TO BE AS SHOWN ON 1/A-103.C. SUITE DOOF OFFICE DOORS TO BE DOOR TYPE 3, FRAME TYPE A, HARDWARE SET 8. PROVIDE TYPICA OFFICE FINISHES. DOORS TO ELECTRICAL & ROOF ACCESS TO BE DOOR TYPE 1, FRAME TA, HARDWARE SET 20. FINISHES TO MATCH SIMILAR CONDITIONS.											
					REVISE GRADING AS SHOWN ON C-601.			OMIT MECHANICAL, ELECTRICAL, AND PLUMBING DEMOLITION ASSOCIATED WITH																							
					OMIT GRADE BEAM & SOG AT VESTIBULE. OMIT COLUMNS, ROOF FRAMING, & MTL DECKING.			EXISTING RESTROOMS. OMIT MEP WORK ASSOCIATED WITH NEW PUBLIC RESTROOMS INLCUDING ALL PLUMBING FIXTURES, DOMESTIC WATER PIPING, WASTE & VENT PIPING, LIGHTING, AND POWER. REMOVE RESTROOM EXHAUST FAN EF-1																							
																												OMIT 2 INTERIOR ROOF DRAINS (RD-1) AND ASSOCIATED STORM DRAIN PIPING. OMIT 2 HOT WATER RADIATORS FTH-6 & FTH-7 & ASSOCIATED HOT WATER PIPING. MOVE BOTH AC-1 AIR CURTAINS, RELOCATE ABOVE NEW SLIDING DOOR LOCATIONS, REROUTE HYDRONIC PIPING AS REQUIRED. DELETE VESTIBULE LIGHTING. RELOCATE M1-300.2 & M1-300.3 SLIDING DOOR OPERATORS, DOOR CONTACTS, DOOR BELLS, INTERCOM, CARD ACCESS READERS W/ POWER & DATA TO NEW DOOR LOCATIONS. OMIT SLIDING DOOR OPERATOR, DOOR BELL & CARD READER FOR DOOR M1-300.4. RELOCATE FIRE ALARM DEVICES TO			INCLUDING ALL ASSOCATED DUCTWORK AND EXHAUST GRILLES. RECONFIGURE MECHANICAL AIR SYSTEM FOR NEW OFFICES. ADD ONE ADDITIONAL VAV BOX. PROVIDE ONE SUPPLY DIFFUSER AND RETURN GRILLE FOR NEW OFFICE. INCREASE SIZE OF STORM AND OVERFLOW DRAIN SERVING ROOF DRAIN AREA #3 TO 8" TO ACCOMODATE REVISED ROOF LAYOUT. RECONFIGURE FIRE SPRINKLERS & ANY INSTALLED FIRE ALARM DEVICES FOR NEW OFFICES.

DEDUCT GENERAL NOTES

 REVIEW DEDUCT DESCRIPTIONS ON G-004 IN CONJUNCTION WITH PLANS, ELEVATIONS, SECTIONS, DETAILS & SCHEDULES. DEDUCTS AS DESCRIBED ON THIS SHEET AND REFERENCED THROUGHOUT THE DRAWING SET ARE DESCRIBED IN WORDS, VIGNETTE SKETCHES, NOTES AND DRAWINGS, HOWEVER, DETAILS FOR EACH DEDUCT ARE NOT INCLUDED. IT IS THE BIDDER'S RESPONSIBILITY TO UNDERSTAND THE SCOPE OF EACH DEDUCT AND TO ALLOW FOR ALL COMPONENTS
AFFECTED IN ORDER TO PROVIDE A COMPLETE ASSEMBLY OR OPERATING SYSTEM. QUESTIONS ON ALTERNATES ARE TO BE RAISED DURING BIDDING.

2. DEDUCT ALTERNATES THAT INCLUDE SUB-LETTERED ITEMS ARE TO BE BID AS ONE DEDUCT ALTERNATE.

3. DEDUCTS WILL BE TAKEN IN SEQUENTIAL ORDER.

> BLDG 26 **KEY PLAN**

DEDUCT DESCRIPTIONS (1)

ENGINEERS & CONSULTANTS: STRUCTURAL

K Design Group, Inc. Since 1989 SK Design Group, Inc. 4600 College Blvd, Suite 100 Overland Park, KS 66211 **Date** 913.451.1818

one eighth inch = one foot

0 4 8 16

VA FORM 08-6231

Description

9201 Ward Parkway, Suite 301 1950 NW Copper Oaks Cr Kansas City, MO 64114

816.444.3144

Blue Springs, MO 64015

InSite Group, Inc.


816.228.3377

913.722.3473

MECHANICAL, ELECTRICAL, PLUMBING, TELECOM, SECURITY FIRE PROTECTION & LIFE SAFETY ASBESTOS ABATEMENT Consulting Engineers and Scientists 9225 Indian Creek Pkwy, Ste 300 13910 W 96th Terrace Overland Park, KS 66210 Lenexa, KS 66215

913.492.7777



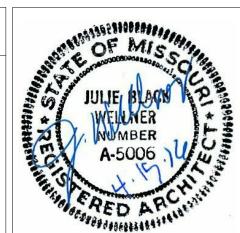

	ARCHITECT:
141000000000000000000000000000000000000	WELLNER architects inc.
E .	Wellner Architects, Inc.
	802 Broadway Blvd, 4th Floor Kansas City, MO 64105
Panil	816.221.0017

	<u> </u>	N.T.S.	1)			
awing Title	Project Title			Project Number		
DEDUCT ALTERNATE DESCRIPTIONS	CONSTRUCT OEF/OIF AND			589-CA3		
		SPECIALTY CARE ADDITION				
proved: Kathleen R. Fogarty, Medical Center Director	Location 4801 LINWOOD BLVD,	KANSAS CITY, M	O 64128	Drawing Number		
	Date	Checked	Drawn	G-0		
	15 April 2016	LMD	MJS	Dwg. 4 of		




NEW MAIN ENTRANCE, WEST APPROACH N.T.S. 1


NOT FOR CONSTRUCTION


	ENGINEERS & CONSUL	TANTS:				OF MISCHING	ARCHITECT:	Drawing Title PROJECT RENDERING	Project Title CONSTRUCT OEF/OIF AND	Project Number 589-CA3-472
	CIVIL STRUCTURAL Leigh & O'	MECHANICAL, ELECTRICAL PLUMBING, TELECOM, SECU	FIRE PROTECTION & LIFE SAFETY	ASBESTOS ABATEMENT	pb pro balance	JULIE BLOOM V. 2	AWELLNER		SPECIALTY CARE ADDITION	Building Number Office of Construction and Facilities Management
	SK Design Group, Inc. Since 1989 SK Design Group, Inc. Leigh & O'Kane	InSite Group, Inc.	FSC, Inc. FSC, Inc.	Consulting Engineers and Scientists Terracon	Pro Balance, Inc.	WEILUNER NUMBER A-5006 U	Wellner Architects, Inc.	Approved: Kathleen R. Fogarty, Medical Center Director	Location 4801 LINWOOD BLVD, KANSAS CITY, MO 64128	Drawing Number Management
No. Description Date	4600 College Blvd, Suite 100 9201 Ward Parkway Overland Park, KS 66211 Kansas City, MO 64 913.451.1818 816.444.3144	Suite 301 1950 NW Copper Oaks Cr Blue Springs, MO 64015 816.228.3377	9225 Indian Creek Pkwy, Ste 300 Overland Park, KS 66210 913.722.3473	13910 W 96th Terrace Lenexa, KS 66215 913.492.7777	5411 West 40 Highway Blue Springs, MO 64015 816.228.7800	RED ARCHINE	802 Broadway Blvd, 4th Floor Kansas City, MO 64105 816.221.0017		Date Checked Drawn 15 April 2016 MJS LMD/A	MM Comparison of the compariso

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VA FORM 08-6231



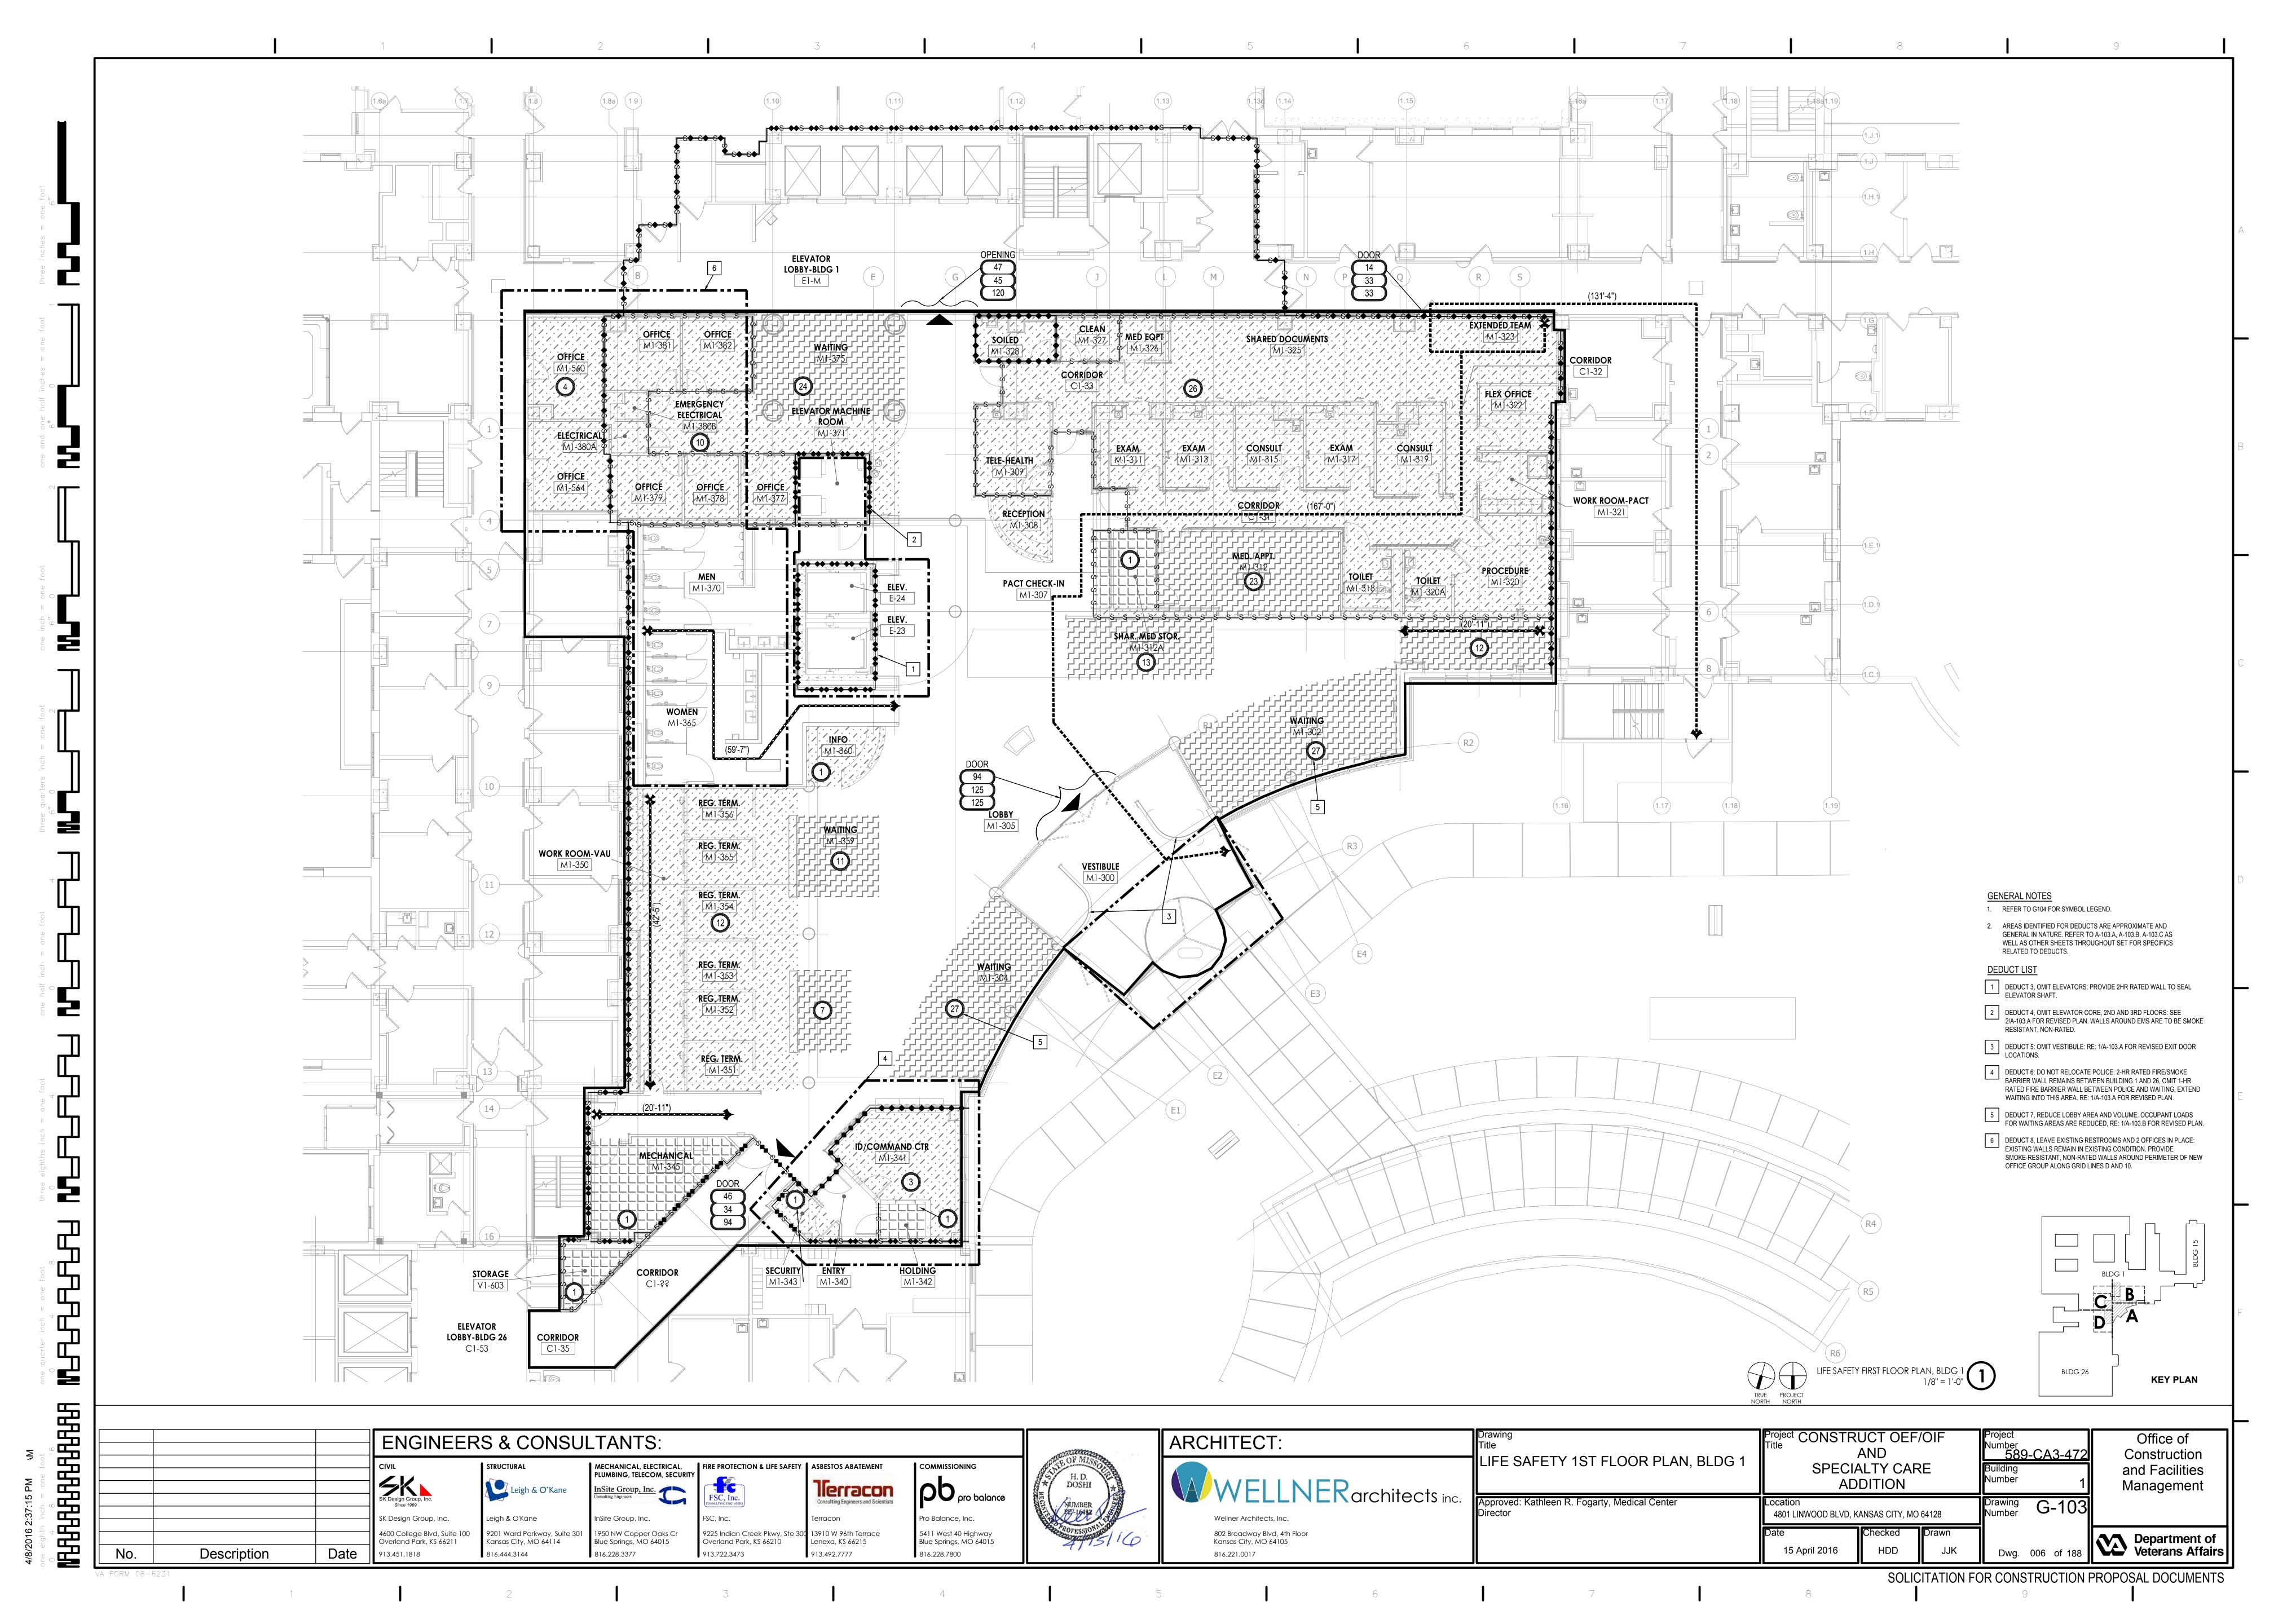

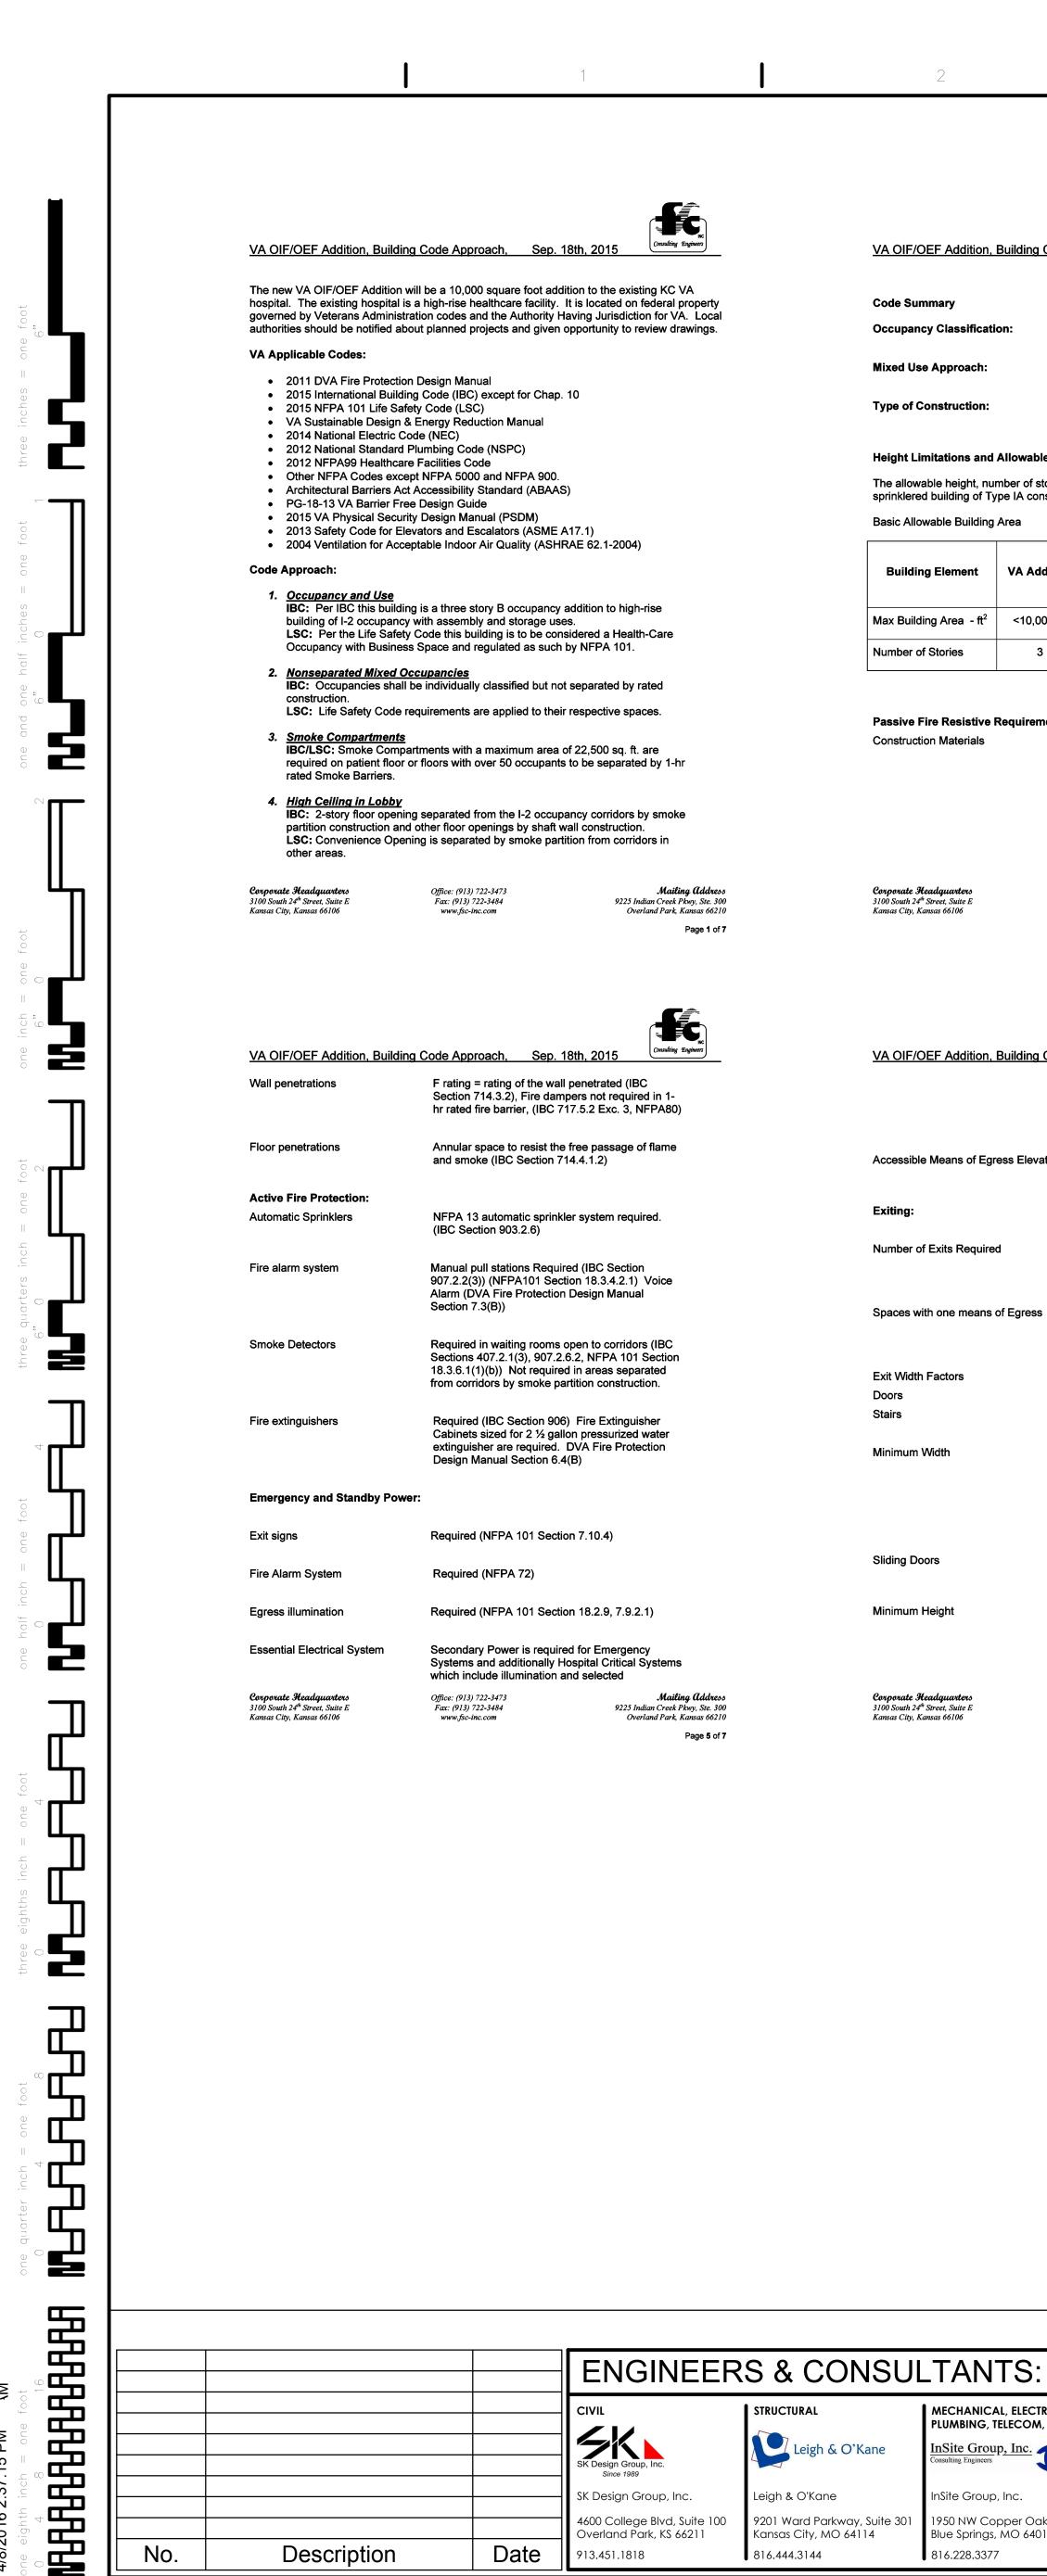

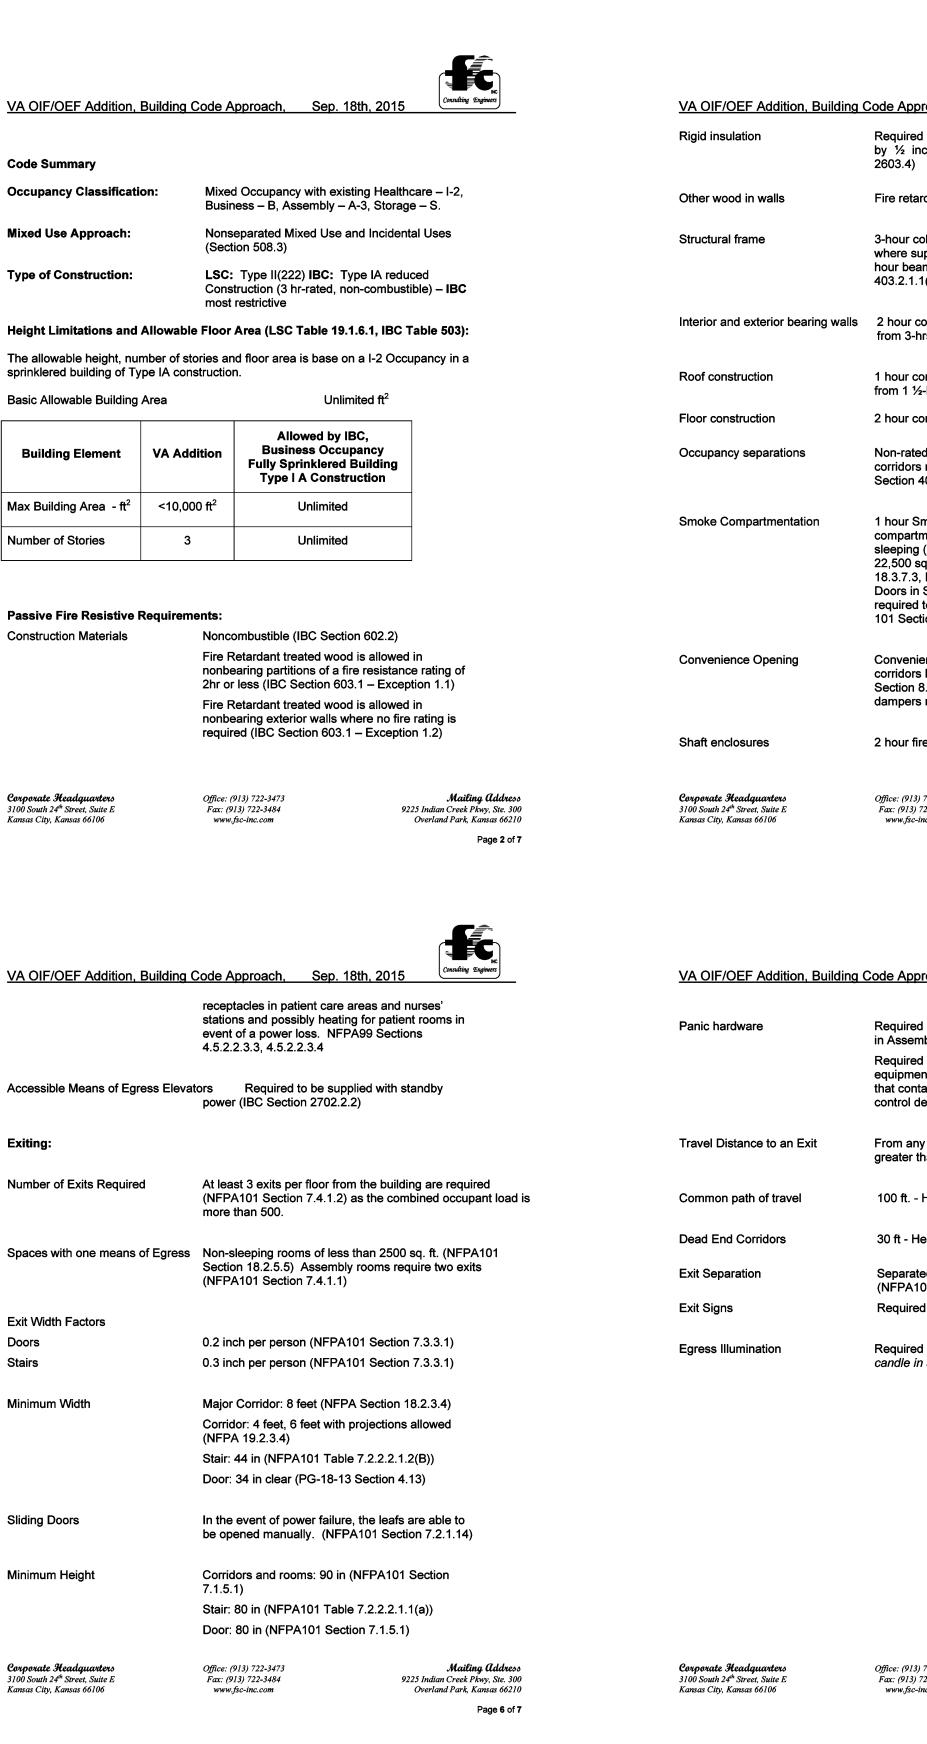MECHANICAL, ELECTRICAL,

PLUMBING, TELECOM, SECURIT

nSite Group, Inc.

1950 NW Copper Oaks Cr

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816.228.3377

9201 Ward Parkway, Suite 301

Kansas City, MO 64114

816.444.3144

SK Design Group, Inc.

Date

Description

No.

4600 College Blvd, Suite 100

Overland Park, KS 66211

FIRE PROTECTION & LIFE SAFETY ASBESTOS ABATEMENT

225 Indian Creek Pkwy, Ste 300 13910 W 96th Terrace

Overland Park, KS 66210

13.722.3473

llerracon

Terracon

Lenexa, KS 66215

pro balance

Pro Balance, Inc.

816.228.7800

5411 West 40 Highway

Blue Springs, MO 64015

oproach, Sep. 18th, 2015
ed to be separated from the interior space inch regular gypsum board (IBC Section)
tardant treated (IBC Section 603.1)
columns where supporting floor, 2-hour supporting roof only (IBC Table 601) 2-eams reduced from 3-hrs (IBC Section 1.1(1))
construction (IBC Table 601), Reduced -hrs by (IBC Section 403.2.1.1(1))
construction (IBC Table 601), Reduced ½-hr (IBC Section 403.2.1.1(1))
construction (IBC Table 601)
ted smoke partition separation from hospital rs required. (NFPA101 18.3.6.1, IBC n 407.2.1)
Smoke Barriers creating smoke rtments subdividing every floor with patient ag (50 or more) with a maximum area of sq. ft. each. (NFPA 101 Sections 18.3.7.1, 3, IBC Section 407.5) Cross Corridor in Smoke Barriers or Horizontal Exits ad to be provided with vision panels. (NFPA section 20.3.7.11
nience opening to be separated from rs by a smoke partition. (NFPA 101 n 8.6.9.1(5)). (IBC Section 712,1.9) Smoke rs not required. (NFPA 101 Section
fire barrier shaft. (IBC Section 713.4)
13) 722-3473 Mailing Address 3) 722-3484 9225 Indian Creek Pkwy, Ste. 300 c-inc.com Overland Park, Kansas 66210 Page 3 of 7
ed (NFPA101 Section 12.2.2.2.3) on room exit doors embly occupancies with over 100 occupants. ed (NEC 110.26(C)(3)) in electrical rooms with nent rated 800 amperes or more and over 6 ft wide ntain over current devices, switching devices, or devices. In point in a Healthcare Occupancy to an exit not r than 200 ft. (NFPA101 Section 19.2.6.2.1) - Healthcare (NFPA101 Section 18.2.5.3) Healthcare (NFPA101 Section 19.2.5.2) ated by one-third the diagonal of the area served (NFPA101 Section 7.5.1.3.3) red (NFPA101 Section 7.10.1.2.1, Section 18.2.10) ed - 1 ft-candle on walking surfaces, 10 ft-in stairs (NFPA101 Section 19.2.8)
13) 722-3473 Mailing Addre ss 3) 722-3484 9225 Indian Creek Pkwy, Ste. 300 c-inc.com Overland Park, Kansas 66210 Page 7 of 7

tor Hoist ways	2-hour rated fire barrier shaft end minute doors. (IBC Section 3002)						
tor lobbies	Not required as does not connect stories. (IBC Section 3006.2)	et more than 3					
tor machine rooms	2-hr (IBC Section 3006.4)						
or nonbearing walls	0 hour construction (IBC Table 6	02)					
or permanent partitions	0 hour (IBC Table 601)						
lors	0 hour construction (NFPA101 Section 18.3.6.2.2) but designed to limit the transfer of smoke (NFPA101 Section 18.3.6.2.3)						
ical room	1 hour walls and ceiling (45 minute doors provided with panic hardware and swinging in direction of egress when equipment is rated at 800 amps or more and over 6 ft wide) with fire dampers (NEC 110.26(C)(3), 450.42 Exc.1)						
ental Storage rooms>50 sq ft		Construction to resist the passage of smoke (IBC Section 509.4.2) 0 hour (NFPA101 Section 18.3.2.1.2)					
ental Storage rooms>100 sq ft	1-hr (NFPA101 Section 18.3.2.1.	2)					
l linen & trash rooms	1 hour where 64 gallons is excee 18.3.2.1.2)	ded (LSC Section					
e Operations Room	Fire resistive, UL 752 Level 3 b	allistic-resistant					
e Holding Room	(PSDM 5.13.3.1) Masonry construction UL 752 L						
	entry resistant (PSDM 5.13.3.2)						
ate Headquarters uh 24 th Street, Suite E	Office: (913) 722-3473 Fax: (913) 722-3484	Mailing Address 9225 Indian Creek Pkwy, Ste. 300					
City, Kansas 66106	www.fsc-inc.com	Overland Park, Kansas 66210 Page 4 of 7					
		1 490 4 61 7					
	E)	(IT AND EGRESS LEGEND					
	$\overline{}$	EGRESS DOOR WITH EXIT SIGN					
		WHERE EXIT DOORS INSTALLED SWING IN THE DIRECTION OF EGRESS AND HAVE EXIT SIGN WITH PANIC HARDWARE					
	→ XXX	DIRECTION OF EGRESS AND HAVE EXIT SIGN WITH					
	(XXX'-X")	DIRECTION OF EGRESS AND HAVE EXIT SIGN WITH PANIC HARDWARE					
	(XXX'-X")	DIRECTION OF EGRESS AND HAVE EXIT SIGN WITH PANIC HARDWARE DIRECTION OF EGRESS WITH POPULATION					
	(XXX'-X")	DIRECTION OF EGRESS AND HAVE EXIT SIGN WITH PANIC HARDWARE DIRECTION OF EGRESS WITH POPULATION TRAVEL DISTANCE					
	(XXX'-X")	DIRECTION OF EGRESS AND HAVE EXIT SIGN WITH PANIC HARDWARE DIRECTION OF EGRESS WITH POPULATION TRAVEL DISTANCE COMMON PATH OF TRAVEL INDICATES NUMBER OF OCCUPANTS					
	(XXX'-X") (XXX'-X") (XXXN'-X") (XXXV-X")	DIRECTION OF EGRESS AND HAVE EXIT SIGN WITH PANIC HARDWARE DIRECTION OF EGRESS WITH POPULATION TRAVEL DISTANCE COMMON PATH OF TRAVEL INDICATES NUMBER OF OCCUPANTS DOORS OR STAIRS OR OPENINGS					
	(XXX'-X") (XXX'-X") (XXN'-X") NNNN NNNN	DIRECTION OF EGRESS AND HAVE EXIT SIGN WITH PANIC HARDWARE DIRECTION OF EGRESS WITH POPULATION TRAVEL DISTANCE COMMON PATH OF TRAVEL INDICATES NUMBER OF OCCUPANTS DOORS OR STAIRS OR OPENINGS NUMBER OF OCCUPANTS					
	(XXX'-X") (XXX'-X") (XXN'-X") (XXX'-X") (XXX'-X") (XXX'-X")	DIRECTION OF EGRESS AND HAVE EXIT SIGN WITH PANIC HARDWARE DIRECTION OF EGRESS WITH POPULATION TRAVEL DISTANCE COMMON PATH OF TRAVEL INDICATES NUMBER OF OCCUPANTS DOORS OR STAIRS OR OPENINGS NUMBER OF OCCUPANTS REQUIRED WIDTH (INCHES)					
	(XXX'-X") (XXX'-X") (XXN'-X") NNNN NNNN	DIRECTION OF EGRESS AND HAVE EXIT SIGN WITH PANIC HARDWARE DIRECTION OF EGRESS WITH POPULATION TRAVEL DISTANCE COMMON PATH OF TRAVEL INDICATES NUMBER OF OCCUPANTS DOORS OR STAIRS OR OPENINGS NUMBER OF OCCUPANTS					
	(XXX'-X") (XXX'-X") (XXN'-X") (XXX'-X") (XXX'-X") (XXX'-X")	DIRECTION OF EGRESS AND HAVE EXIT SIGN WITH PANIC HARDWARE DIRECTION OF EGRESS WITH POPULATION TRAVEL DISTANCE COMMON PATH OF TRAVEL INDICATES NUMBER OF OCCUPANTS DOORS OR STAIRS OR OPENINGS NUMBER OF OCCUPANTS REQUIRED WIDTH (INCHES)					
	(XXX'-X") (XXX'-X") (XXXV-X") (XXXV-X") (XXXV-X") (XXXV-X") (XXXV-X")	DIRECTION OF EGRESS AND HAVE EXIT SIGN WITH PANIC HARDWARE DIRECTION OF EGRESS WITH POPULATION TRAVEL DISTANCE COMMON PATH OF TRAVEL INDICATES NUMBER OF OCCUPANTS DOORS OR STAIRS OR OPENINGS NUMBER OF OCCUPANTS REQUIRED WIDTH (INCHES)					
	(XXX'-X") (XXX'-X") (XXXY-X")	DIRECTION OF EGRESS AND HAVE EXIT SIGN WITH PANIC HARDWARE DIRECTION OF EGRESS WITH POPULATION TRAVEL DISTANCE COMMON PATH OF TRAVEL INDICATES NUMBER OF OCCUPANTS DOORS OR STAIRS OR OPENINGS NUMBER OF OCCUPANTS REQUIRED WIDTH (INCHES) AVAILABLE WIDTH (INCHES)					
	(XXX'-X")	DIRECTION OF EGRESS AND HAVE EXIT SIGN WITH PANIC HARDWARE DIRECTION OF EGRESS WITH POPULATION TRAVEL DISTANCE COMMON PATH OF TRAVEL INDICATES NUMBER OF OCCUPANTS DOORS OR STAIRS OR OPENINGS NUMBER OF OCCUPANTS REQUIRED WIDTH (INCHES) AVAILABLE WIDTH (INCHES) S REQUIREMENTS TH FACTORS E PROTECTED					
	(XXX'-X")	DIRECTION OF EGRESS AND HAVE EXIT SIGN WITH PANIC HARDWARE DIRECTION OF EGRESS WITH POPULATION TRAVEL DISTANCE COMMON PATH OF TRAVEL INDICATES NUMBER OF OCCUPANTS DOORS OR STAIRS OR OPENINGS NUMBER OF OCCUPANTS REQUIRED WIDTH (INCHES) AVAILABLE WIDTH (INCHES) S REQUIREMENTS TH FACTORS E PROTECTED DICKE PROTECTED					
TAIRS	(XXX'-X")	DIRECTION OF EGRESS AND HAVE EXIT SIGN WITH PANIC HARDWARE DIRECTION OF EGRESS WITH POPULATION TRAVEL DISTANCE COMMON PATH OF TRAVEL INDICATES NUMBER OF OCCUPANTS DOORS OR STAIRS OR OPENINGS NUMBER OF OCCUPANTS REQUIRED WIDTH (INCHES) AVAILABLE WIDTH (INCHES) S REQUIREMENTS TH FACTORS E PROTECTED					
TAIRS OORS AND RAMPS <1:12	(XXX'-X")	DIRECTION OF EGRESS AND HAVE EXIT SIGN WITH PANIC HARDWARE DIRECTION OF EGRESS WITH POPULATION TRAVEL DISTANCE COMMON PATH OF TRAVEL INDICATES NUMBER OF OCCUPANTS DOORS OR STAIRS OR OPENINGS NUMBER OF OCCUPANTS REQUIRED WIDTH (INCHES) AVAILABLE WIDTH (INCHES) S REQUIREMENTS TH FACTORS E PROTECTED DICKE PROTECTED					
	(XXX'-X") (XXX'-X") (XXXY-X") (XXY-X") (XXXY-X") (DIRECTION OF EGRESS AND HAVE EXIT SIGN WITH PANIC HARDWARE DIRECTION OF EGRESS WITH POPULATION TRAVEL DISTANCE COMMON PATH OF TRAVEL INDICATES NUMBER OF OCCUPANTS DOORS OR STAIRS OR OPENINGS NUMBER OF OCCUPANTS REQUIRED WIDTH (INCHES) AVAILABLE WIDTH (INCHES) S REQUIREMENTS TH FACTORS E PROTECTED DICKE PROTECTED 0.3 INCHES PER PERSON (NFPA 101 SECTION 7.3.3.1)					
	(XXX'-X") (XXX'-X") (XXXY-X") (XXY-X") (XXXY-X") (DIRECTION OF EGRESS AND HAVE EXIT SIGN WITH PANIC HARDWARE DIRECTION OF EGRESS WITH POPULATION TRAVEL DISTANCE COMMON PATH OF TRAVEL INDICATES NUMBER OF OCCUPANTS DOORS OR STAIRS OR OPENINGS NUMBER OF OCCUPANTS REQUIRED WIDTH (INCHES) AVAILABLE WIDTH (INCHES) PROTECTED OKE PROTECTED 0.3 INCHES PER PERSON (NFPA 101 SECTION 7.3.3.1) 0.2 INCHES PER PERSON (NFPA 101 SECTION 7.3.3.1)					

VA OIF/OEF Addition, Building Code Approach, Sep. 18th, 2015

HEALTH CA	ARE		300 FEET (NFPA 101 SEC	300 FEET (NFPA 101 SECTION 18.2.6.2.1			
		COMMON	PATH OF TRAVEL	ATH OF TRAVEL			
HEALTH CA	ARE		100 FEET (NFPA 101 SECT	100 FEET (NFPA 101 SECTION 18.2.5.3)			
WALL TYPE	FIRE RATING (HOUR)	OPENING FIRE RATING (HOUR)	DAMPERS F: FIRE S: SMOKE	WALL PENETRATION RATING (HOUR)			
——S—S—S—S—S—S—S SMOKE RESISTANT NON-RATED PARTITION	0	SELF-CLOSING TIGHT FITTING	S IN AIR TRANSFER WALL OPENING	0 WITH TIGHT INSTALLATION			
1-HOUR FIRE BARRIER WALL	1	3/4	WALLS: F IN UNDUCTED OPENINGS.	1			
*************************************			SHAFT: F & S IN DUCTED				

1/3

1.5

AND UNDUCTED OPENINGS.

S IN DUCTED OPENINGS

F & S IN DUCTED OPENINGS

(SECTION 717.5.3)

CORRIDOR C3-312 386 SF. 4	
LIFE SAFETY 3RD FLOOR PLAN 1/8" = 1'-0" DEDUCT LIST 1 DEDUCT 3: PROVIDE 2-HR RATED ASSEMBLY TO SEAL THE ELEVATOR SHAFT. DEDUCT 4: OMIT WORK ON THIS FLOOR.	
UNOCCUPIED ROOF 30RRIDOR C2.31 396 SF.	-
LIFE SAFETY 2ND FLOOR PLAN 1/8" = 1'-0" DEDUCT LIST 1 DEDUCT 2: PROVIDE 2-HR RATED ASSEMBLY TO SEAL THE ELEVATOR SHAFT.	
DEDUCT 4: OMIT WORK ON THIS FLOOR.	
BLDG 26 KEY PLAN	

USE	SYMBOL	OCCUPANT LOAD FACTOR (FT²/PERSON)
ASSEMBLY TABLES & CHAIRS		15
MECHANICAL ELECTRICAL STORAGE		300
OFFICE		100

	NON-RATED PARTITION
CUPANT LOAD FACTOR T2/PERSON)	1-HOUR FIRE BARRIER WALL
300	2-HOUR FIRE BARRIER WALL
	→S →S →S →S →S →S 1-HOUR FIRE / SMOKE BARRIER WALL
100	

816.221.0017

y.	ARCHITECT:	Dra Title
-	WELLNER architects inc.	LI Bl
	Wellner Architects, Inc.	App Dire
)	802 Broadway Blvd, 4th Floor Kansas City, MO 64105	

E SAFETY 2ND & 3RD FLOOR PLANS, DG 1	II ' GONGINOGI GEL/GIL I			Project Number 589-CA3-472 Building Number 1		and Facilities Management	
oved: Kathleen R. Fogarty, Medical Center tor	Location 4801 LINWOOD BLVD, KANSAS CITY, MO 64128			Drawing Number	G-104		
	Date 15 April 2016	Checked HDD	Drawn JJK	Dwg.	007 of 188	Department of Veterans Affairs	

SOLICITATION FOR CONSTRUCTION PROPOSAL DOCUMENTS

